



VICINITY MAP

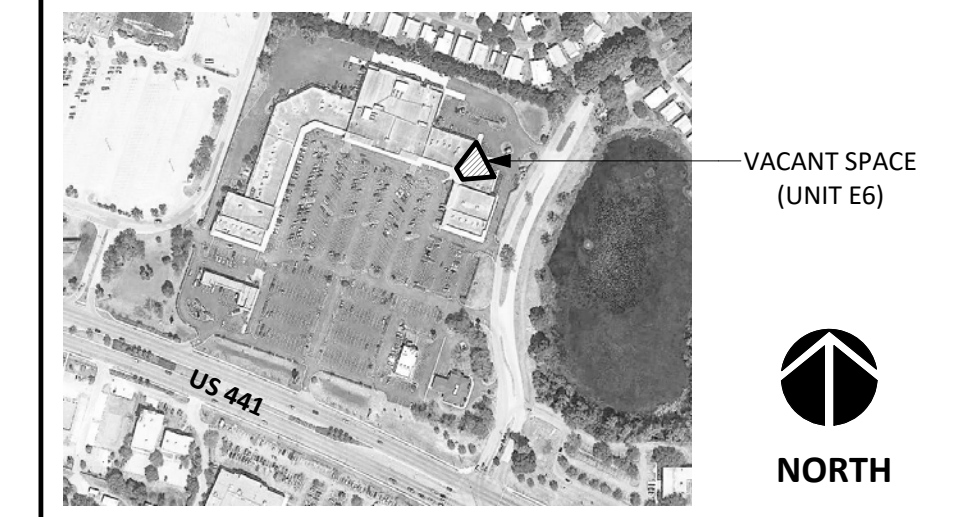


DISCLAIMER:
THESE DOCUMENTS HAVE BEEN PREPARED FOR INFORMATION ONLY AND ARE NOT PROVIDED FOR CONSTRUCTION. ALL DIMENSIONS AND EXISTING CONDITIONS MUST BE FIELD VERIFIED PRIOR TO ANY CONSTRUCTION.
FIELD MEASUREMENTS ARE RECORDED TO THE NEAREST 1/32" AS DOCUMENTED IN THE FINAL CAD (DWG) DOCUMENT. DIMENSIONS SHOWN ARE ROUNDED TO THE NEAREST 1" FOR CLARITY.

GENERAL INFORMATION:

NO. OF LEVELS:	1
BUILDING HEIGHT:	+/- 20'-0" (TOP OF PARAPET)
RESTROOM (ADA) COMPLIANCE:	NON-COMPLIANT
<i>*REFER TO LOD SUPPLEMENT</i>	
STRUCTURAL SPOT ELEVATIONS	
<i>*REFER TO PLAN FOR LOCATIONS</i>	
BS =	BOTTOM OF STRUCT.
BD =	BOTTOM OF DECKING
FIRE PROTECTION (SPRINKER):	YES
FIRE ALARM:	NO
WATER METER:	N/A
WATER HEATER (WH1):	WHIRLPOOL - (ELEC)
<i>* LABEL NOT LEGIBLE</i>	
GAS METER:	N/A



WATER HEATER



FIRE RISER

LEGEND


54" HIGH @ 4'-0"	= SILL/HEAD HEIGHT	FA	= FIRE ALARM (PULL STATION)
6"	= DOOR WIDTH/TYPE	FS	= FIRE STROBE
⊙	= SPOT ELEVATION	CF	= CEILING FAN
⊗	= FIRE EXTINGUISHER	RD	= ROOF DRAIN (INTERNAL)
⊥	= STUB FOR PLUMBING		




1 RESTROOM COMPLIANCE (PHOTOS)
NOT TO SCALE



2 ELEVATION (PHOTO)
NOT TO SCALE

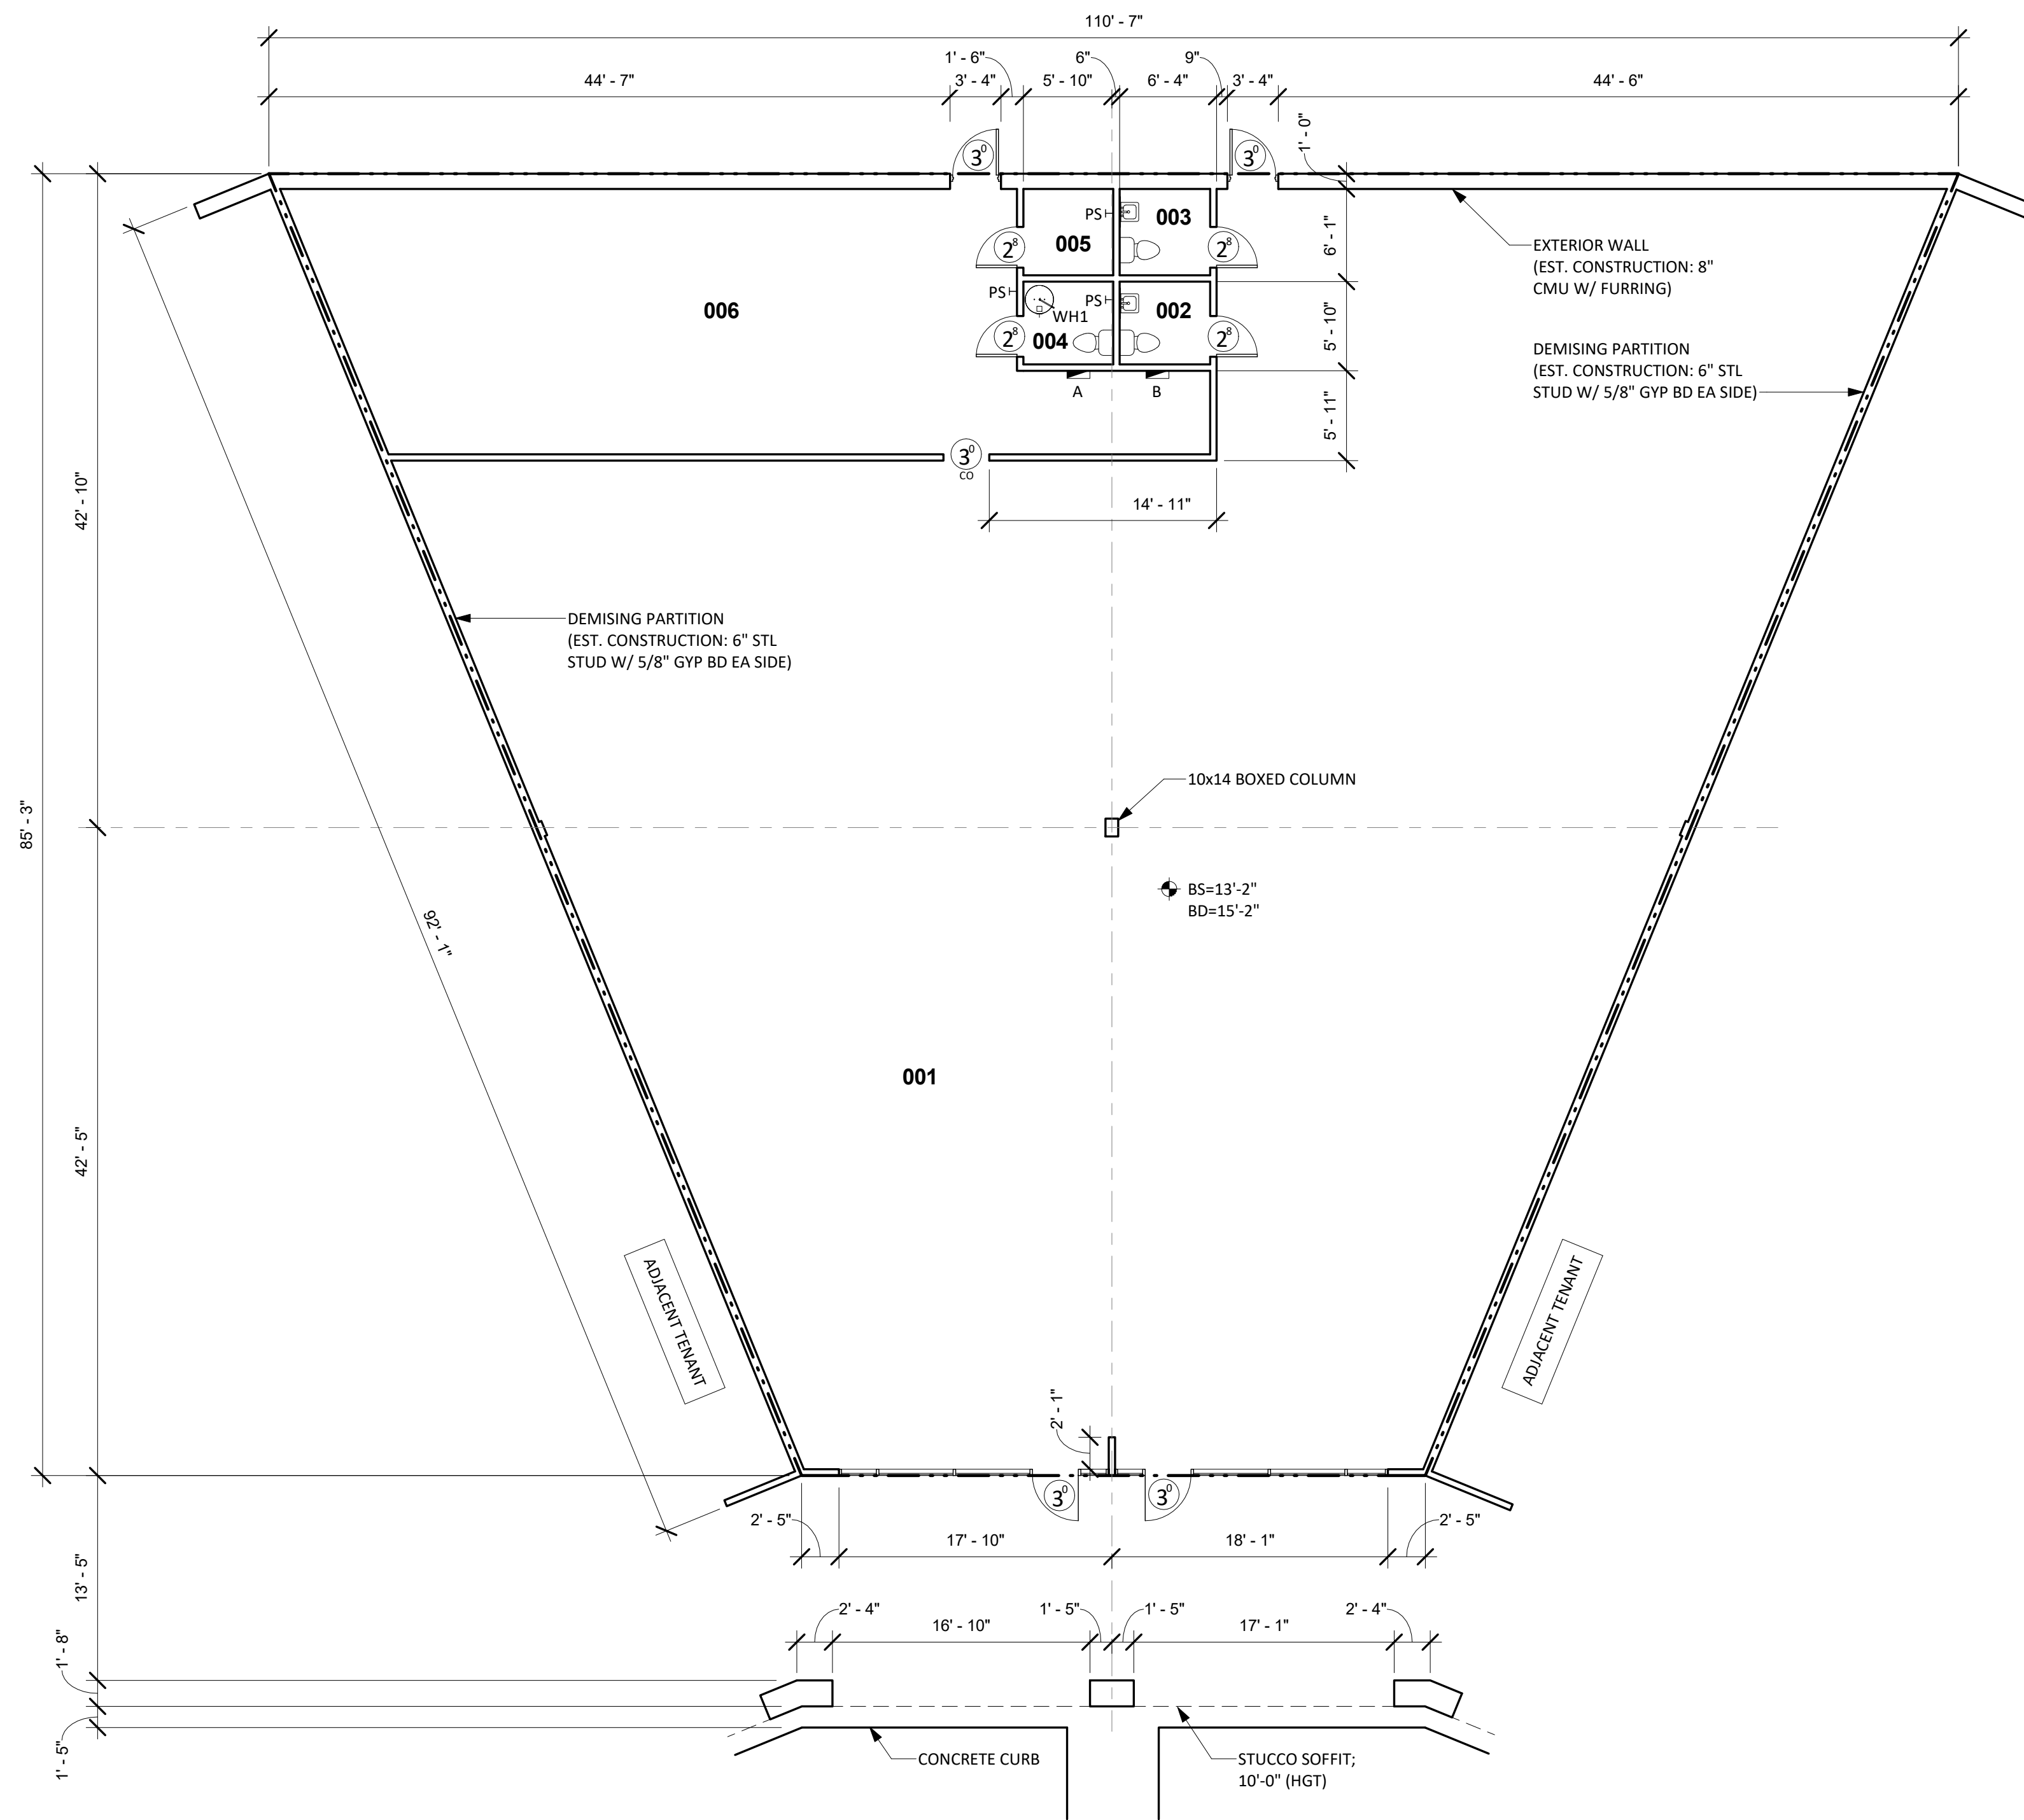

4 EXISTING FLOOR PLAN
1/8" = 1'-0"

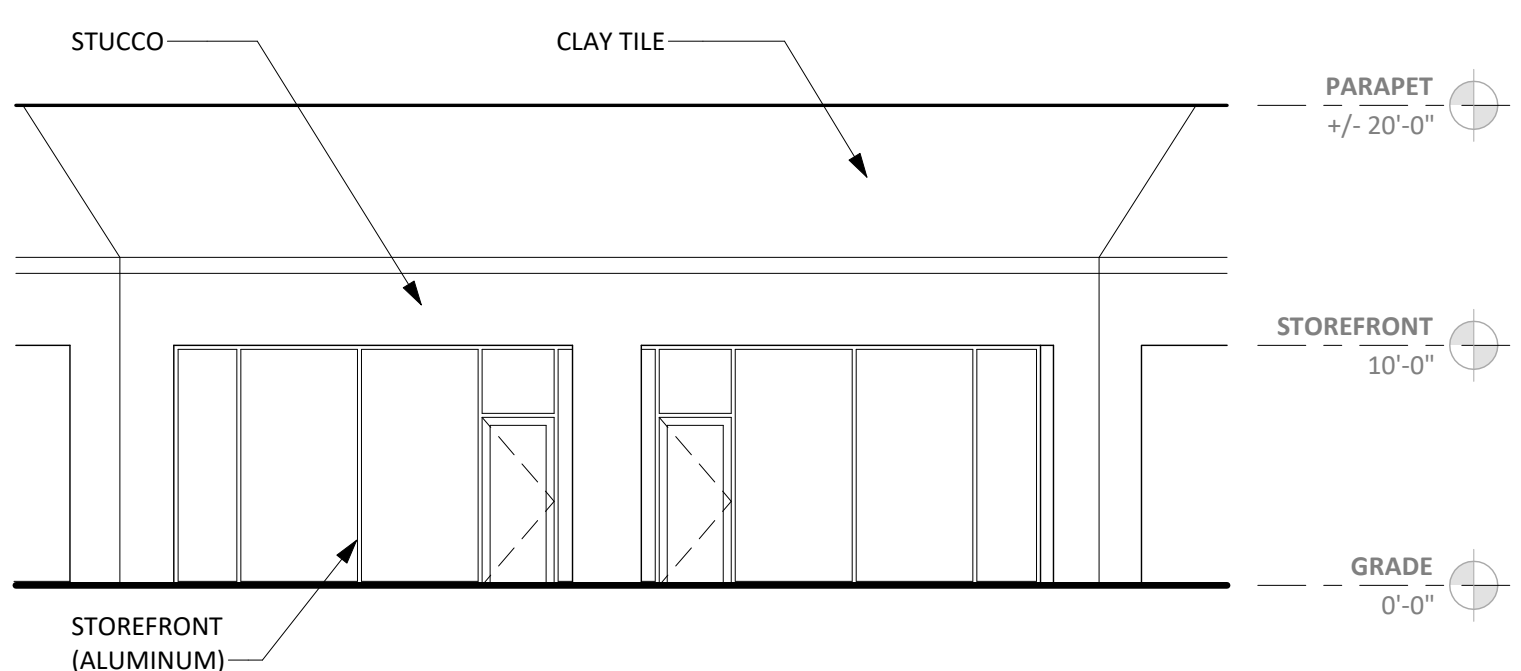

3 FRONT ELEVATION
1/8" = 1'-0"



EXISTING ELECTRICAL SUMMARY

COMPONENT	MANUFACTURE	CATALOG NO.	VOLTAGE	AMPS	PHASING	CIRCUITS	COMMENTS
PANEL A	SQUARE D	QOC442L	120/240	N/A	N/A	25 USED	
PANEL B	SQUARE D	QOC442L	120/240	N/A	N/A	15 USED	

EXISTING FINISH/CONDITIONS SUMMARY (E6)

ROOM	FLR MAT'L	FLR COND.	BASE	WALL MAT'L	WALL COND.	CLG MAT'L	CLG HGT	CLG COND.	ADD'L COMMENTS
001	VCT	POOR	--	GYP BD (PTD)	FAIR	ACT	10'-0"	GOOD	
002	VCT	FAIR	4" RUBBER	GYP BD (PTD)	FAIR	ACT	7'-6"	--	
003	VCT	FAIR	4" RUBBER	GYP BD (PTD)	FAIR	ACT	7'-6"	--	
004	VCT	FAIR	4" RUBBER	GYP BD (PTD)	FAIR	ACT	7'-6"	--	
005	VCT	FAIR	4" RUBBER	GYP BD (PTD)	FAIR	ACT	7'-6"	--	
006	VCT	POOR	--	GYP BD (PTD)	FAIR	ACT	10'-0"	GOOD	

NOTE
01) STOREFRONT: DARK BRONZE/GLASS (GOOD CONDITION)

CONDITION EVALUATION DEFINITION:
(GOOD) - AVERAGE/ABOVE AVERAGE CONDITION. NO REMEDIAL WORK IS RECOMMENDED OR REQUIRED.
(FAIR) - AVERAGE CONDITION. SOME WORK IS RECOMMENDED TO RETURN TO GOOD CONDITION
(POOR) - BELOW AVERAGE CONDITION. SIGNIFICANT WORK SHOULD BE ANTICIPATED TO RESTORE

GLA: 6,453 sf

NORTH

ISSUE DATE
01.16.18

REVISIONS

NO.	DATE	DESCRIPTION

PROJECT NUMBER
7166

Unit E6
Existing Plan

SHEET NUMBER
AS10